From BC MoE Area Standards (05/2012)

Industrial Education

Drafting 120 m²
Technology (existing Electricity/Electronics) 140 m²
Metalwork (use in determining existing cap.) 200 m²
Mechanics 230 m²
Construction (Wood) 275 m²

2.2.3 Area Measurement

Room or Module Areas

Room or module area will be measured net within the inside surfaces of main enclosing walls and partitions.

Undefined Boundaries

Sometimes the boundary between circulation and other spaces such as libraries is not clearly defined. For calculation of allowable areas when this is so, passageways shall be assumed to be not less than 2 m wide where circulation is likely.

Mezzanines

With the exception of Industrial Education mezzanine storage, mezzanines shall be measured and considered as normal floor space

2.6.4 Industrial Education Covered Work Area

In addition to the allowable areas for Industrial Education a roofed, fenced, and paved work area not exceeding 65 m² may be added to each construction, mechanics and middle school general shop. The area of the sawdust extraction equipment room may included either in the covered work area or in the construction shop allowable area, at School Board discretion.

Covered work areas shall not be counted within the gross building area.

Gross Area

The gross area of a building floor is defined as the floor area within the inside of the exterior walls, plus a standard allowance calculated by multiplying the building perimeter (measured at the interior face) times 150 mm.

The following area calculations shall be included in the definition of facility gross floor area:

- stair openings, measured at the first floor, including stairs to rooftop penthouses
- · elevator and duct shafts measured at each floor
- mezzanines including access stairs
- mechanical and electrical spaces, including all penthouse, basement and mezzanine locations (service spaces to be identified separately)
- galleries and suspended walkways, including access stairs
- · all other usable or accessible floor areas.

Excluded areas from the calculations are as follows:

- · industrial education storage mezzanines
- · crawl spaces or service tunnels
- elementary covered play areas
- · industrial education covered work areas.

Shee	t List
Sheet	Sheet
Number	Name

A0	Generic Woodshop
A101	Generic Woodshop Floor Plan
A101.1	Safety Zones
A102	Woodshop Colour Floorplan
A103	Table Layout
A104	Mobile Equipment
A105	Sinks and Entrance
A106	CNC Room
A107	Chopsaws
A108	Area
A109	Metric Details
A110	3D Views

R	oom Schedu	le
Name	Area	Metric

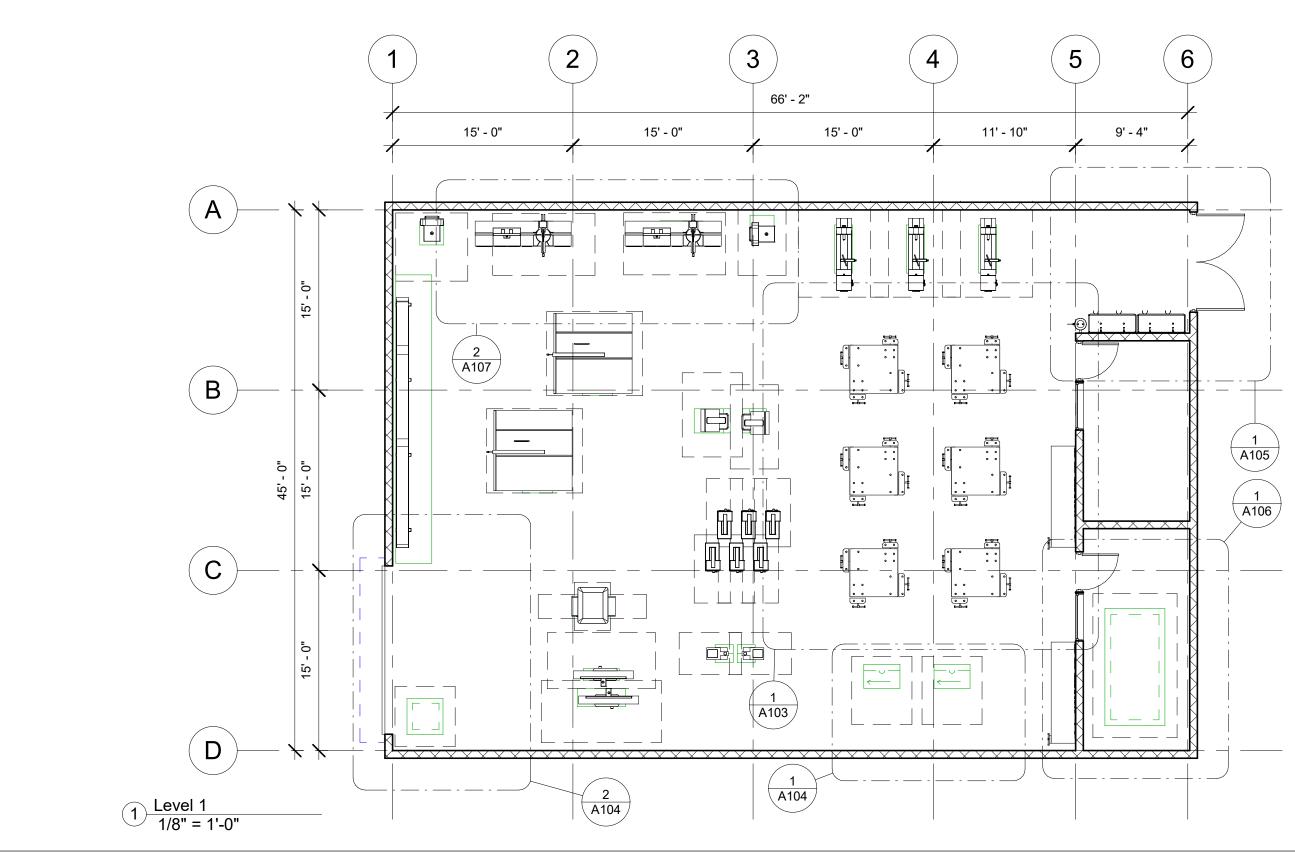
Shop Floor	2655 SF	247 m²
Finishing	133 SF	12 m²
CNC	164 SF	15 m²



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No.	Description	Date

Generic	Woodshop		
Project number	V1	_	
Date	June 2017	A	\cap
Drawn by	Peter Halim	, ,	
Checked by	Checker	Scale	





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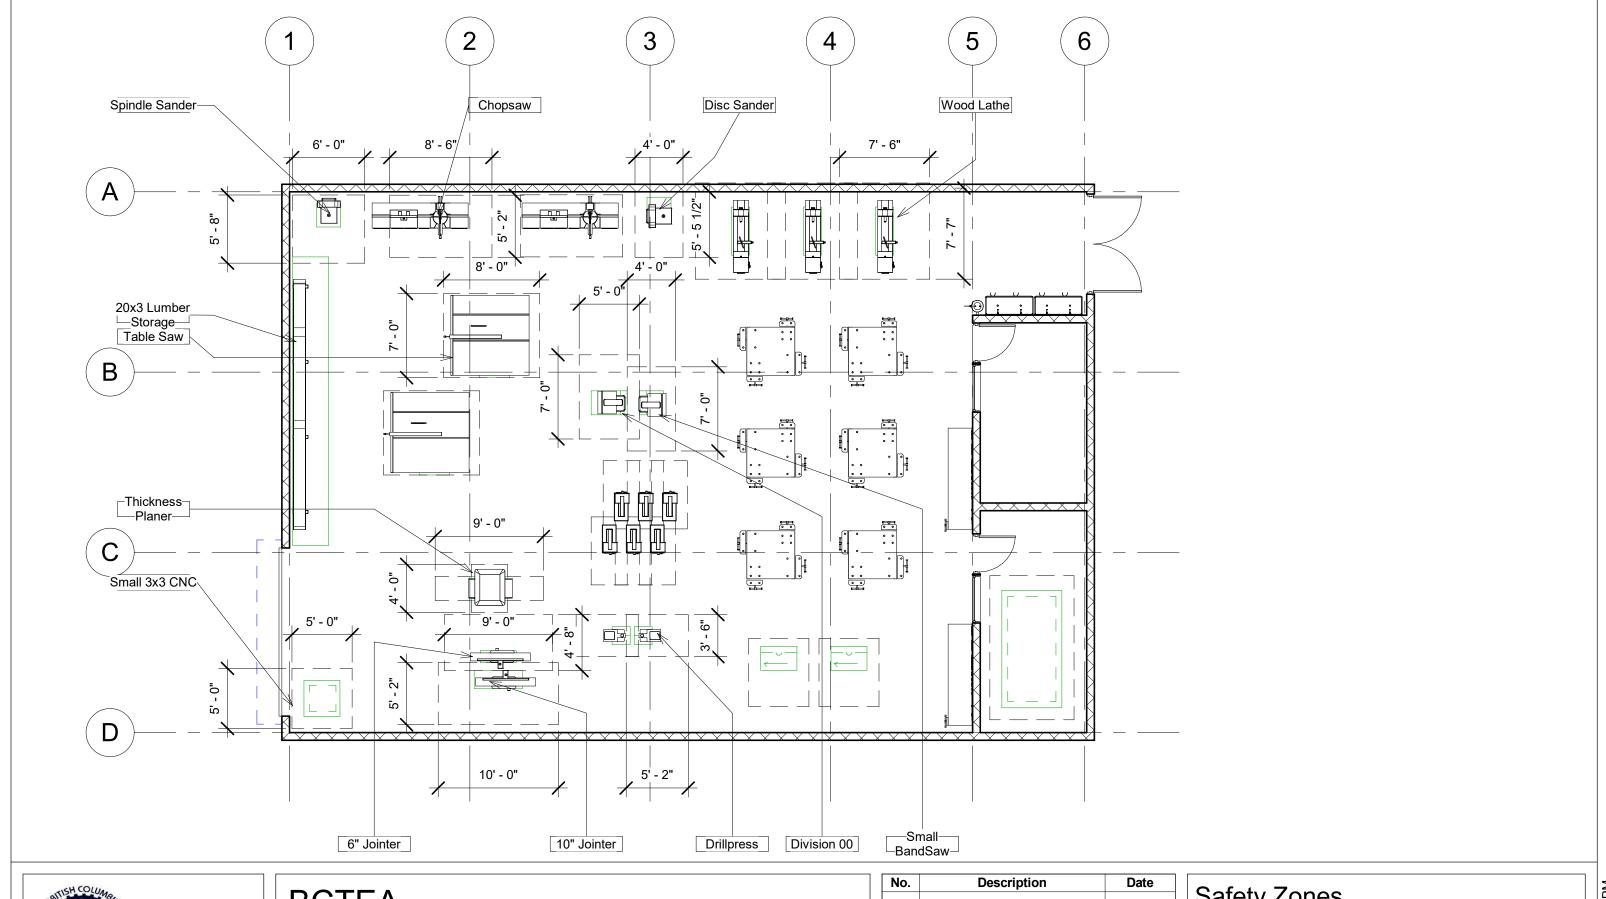
Approved Woodshop Design

No.	Description	Date

Generic	Woodsho	p Floor Plan	

Project number	V1	1 1 0 1
Date	June 2017	A101
Drawn by	Peter Halim	7 (101
Checked by	Checker	Scale 1/8" = 1'-0"

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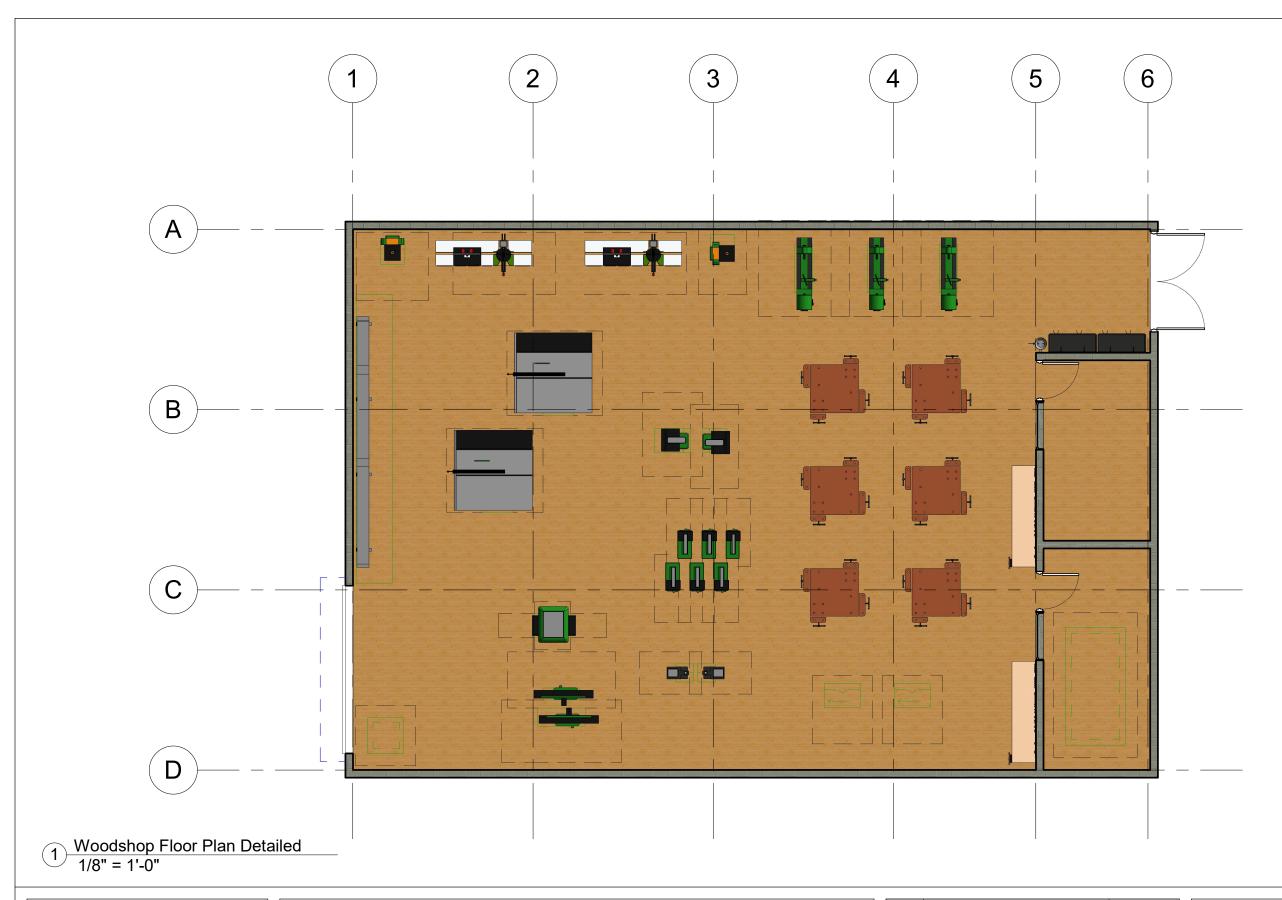




No.	Description	Date

Safety Z	ones	
Project number	V1	
Date	June 2017	A101.1
Drawn by	Peter Halim	7 (10 111
Checked by	Checker	Scale 1/8" = 1'-0"
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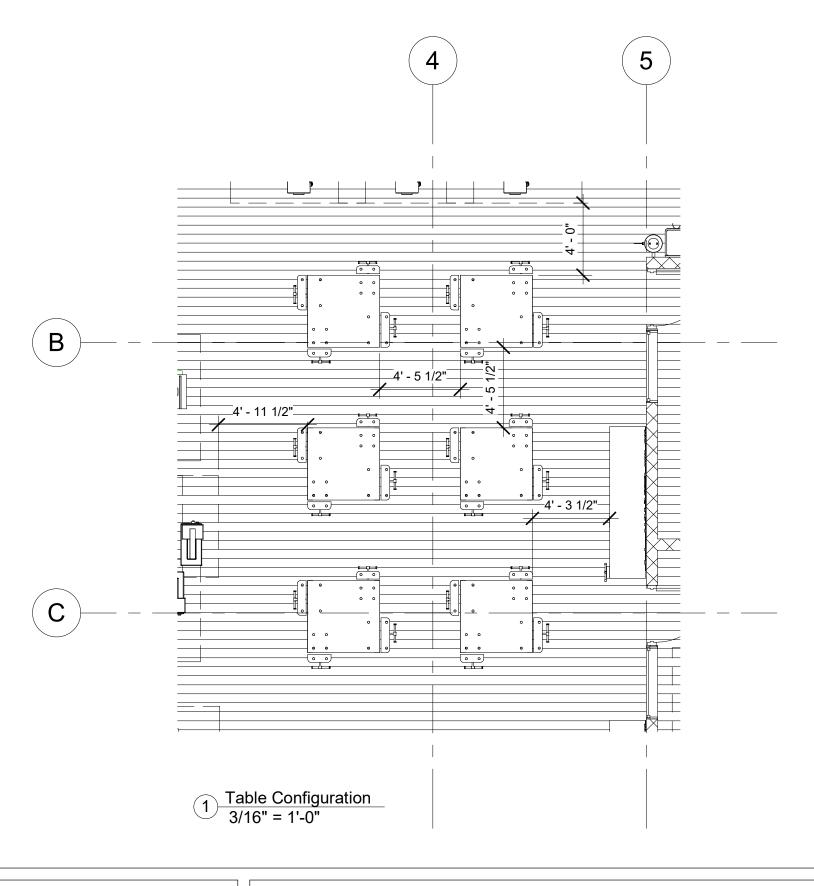
Approved Woodshop Design

No.	Description	Date	
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Voodshop	Colour F	loorplan

roject number	V1	1 100
ate	June 2017	A102
rawn by	Peter Halim	,
hecked by	Checker	Scale 1/8" = 1'-0"

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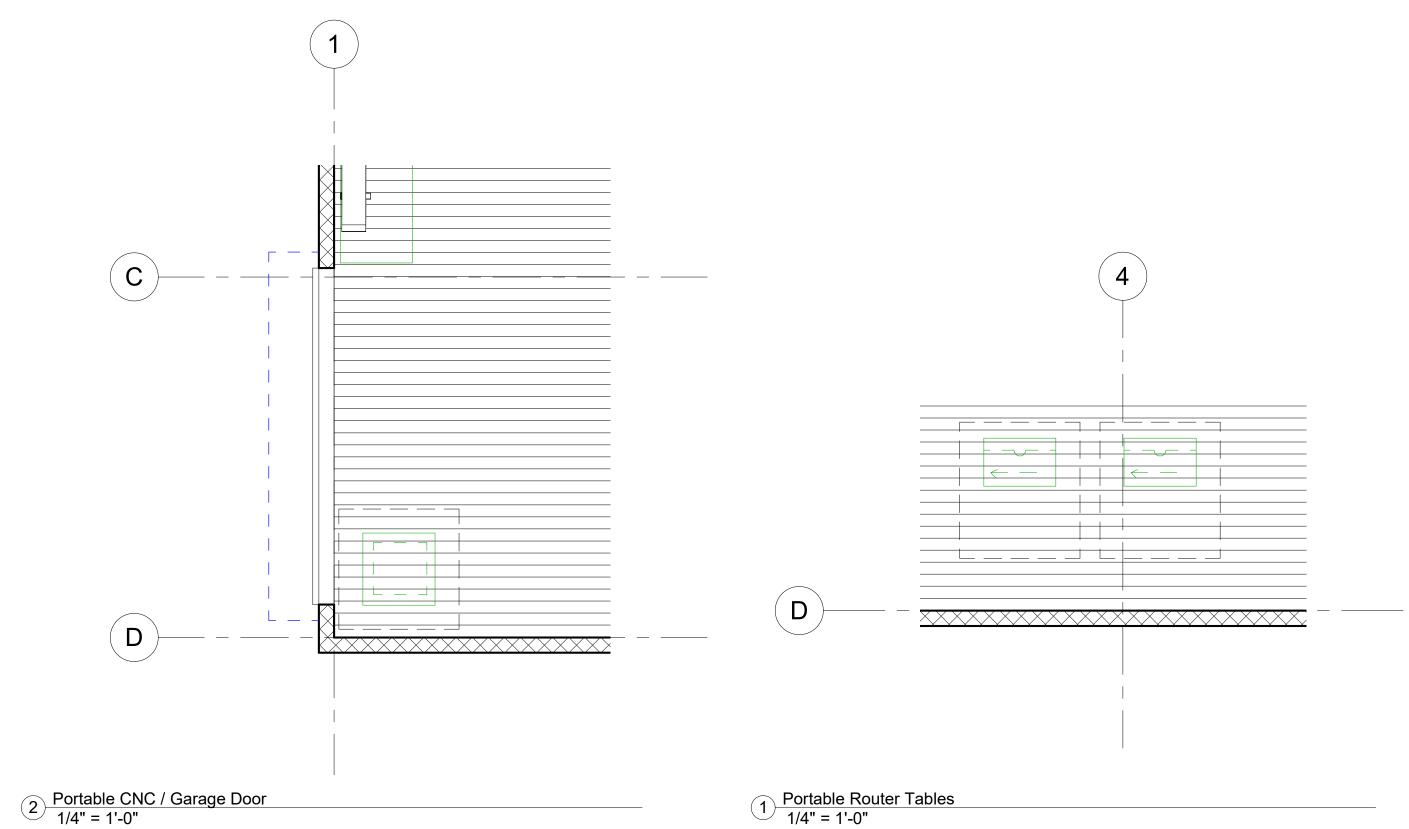


4' by 4' student work tables - 4 students per table



No.	Description	Date	
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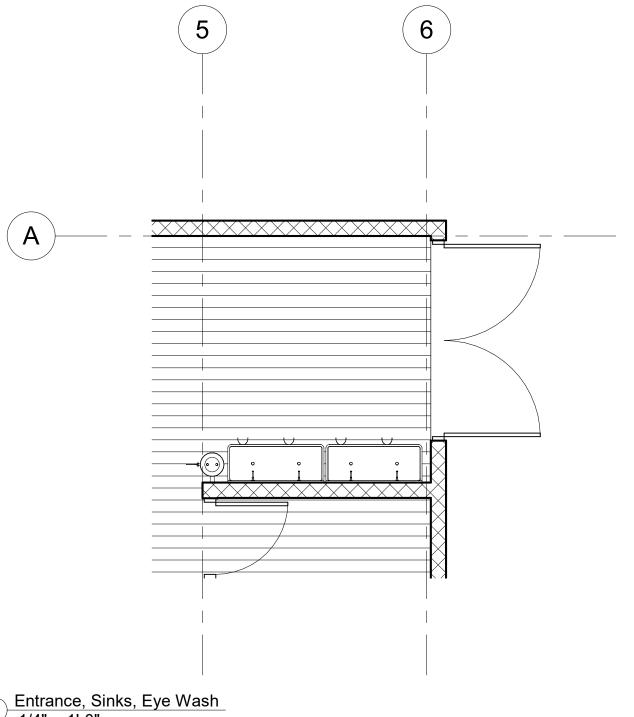
Table Layout			
roject number	V1		
ate	June 2017	A103	
rawn by	Peter Halim		
hecked by	Checker	Scale 3/16" = 1'-0"	





No.	Description	Date

Mobile Equipment			
Project number	V1		
Date	June 2017	A104	1
Drawn by	Peter Halim		
Checked by	Checker	Scale 1/4" = 1'-0"	
			٠






2 Sinks

Entrance, Sinks, Eye Wash 1/4" = 1'-0"



No.	Description	Date	

Sinks and Entrance		Maco	
Project number	V1		7.40.00
Date	June 2017	A105	- 1
Drawn by	Peter Halim	, , , , ,	2/2047
Checked by	Checker	Scale 1/4" = 1'-0"	10,7

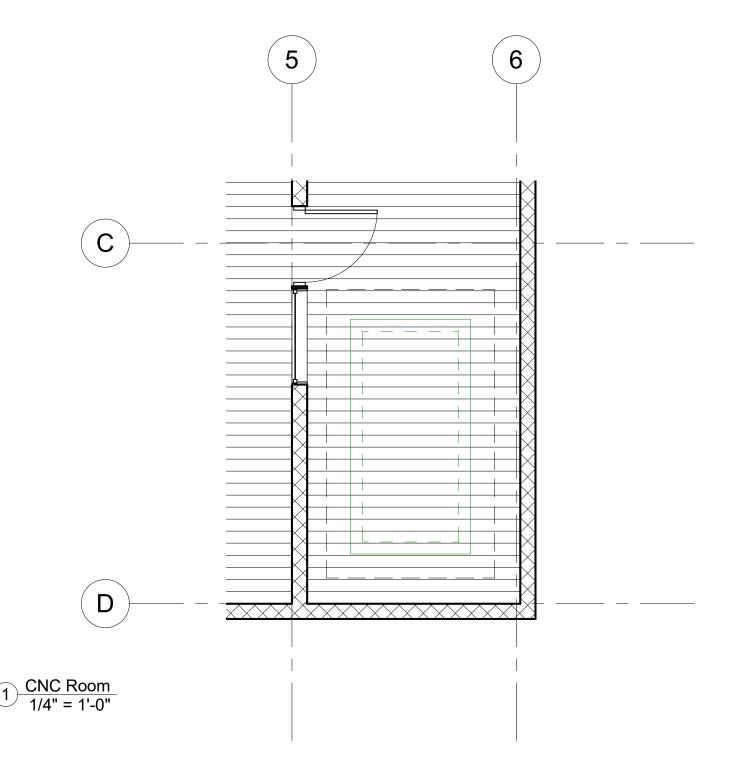




No.	Description	Date

CNC Room			
Project number	V1		
Date	June 2017	A106	
Drawn by	Peter Halim	71100	
Checked by	Checker	Scale 1/4" = 1'-0"	
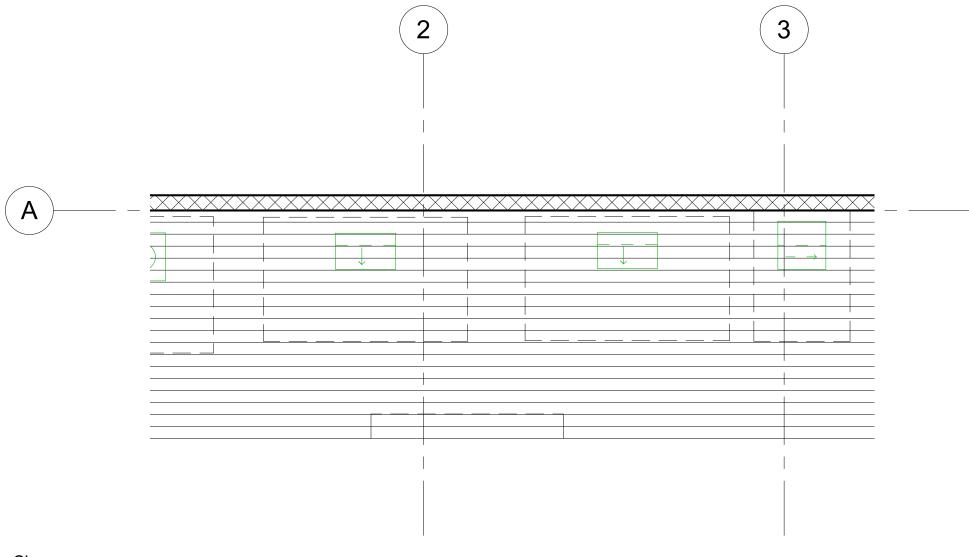
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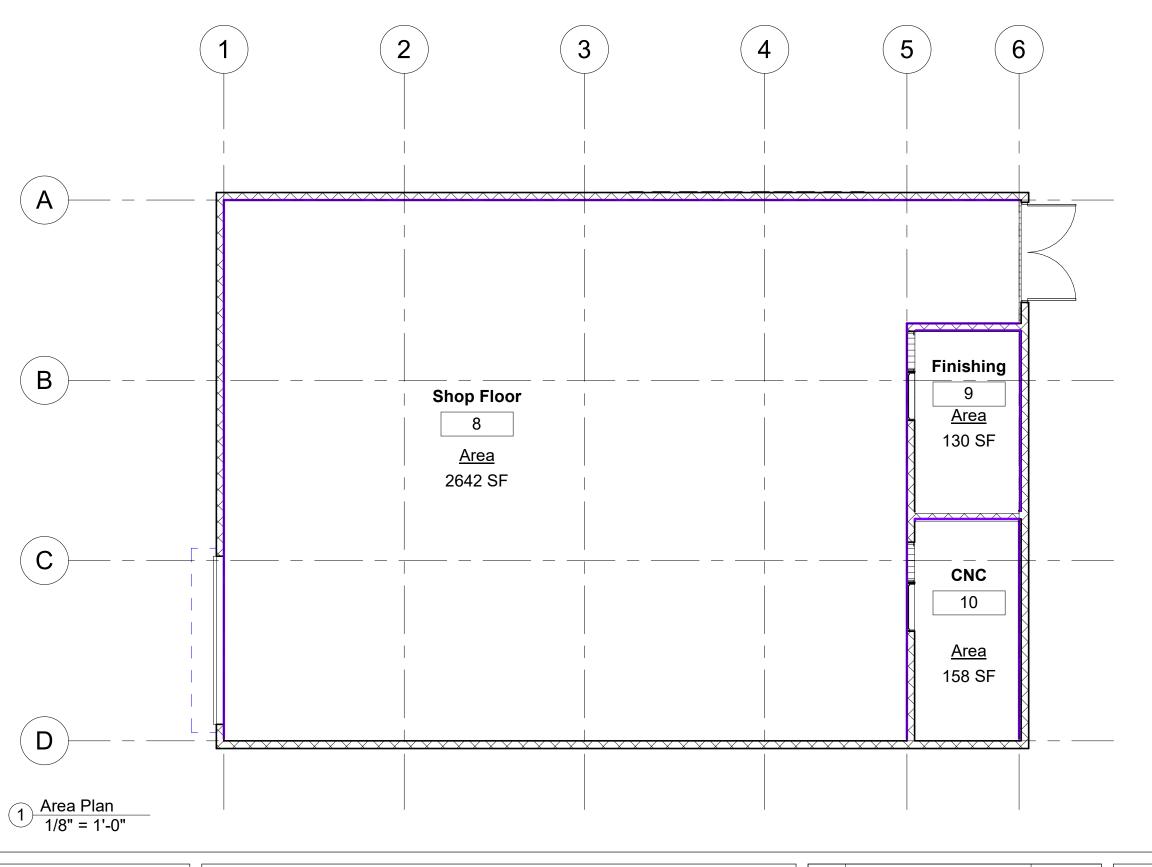


2 Chopsaws 1/4" = 1'-0"



No.	Description	Date

Chopsaws			
Project number	V1		
Date	June 2017	A107	
Drawn by	Peter Halim	, (10)	
Checked by	Checker	Scale 1/4" = 1'-0"	




Room Schedule			
Name	Area	Metric	

Shop Floor	2655 SF	247 m²
Finishing	133 SF	12 m²
CNC	164 SF	15 m ²



No.	Description	Date

Area		
Project number	V1	
Date	June 2017	A108
Drawn by	Peter Halim	, , , , ,
Checked by	Checker	Scale 1/8" = 1'-0"

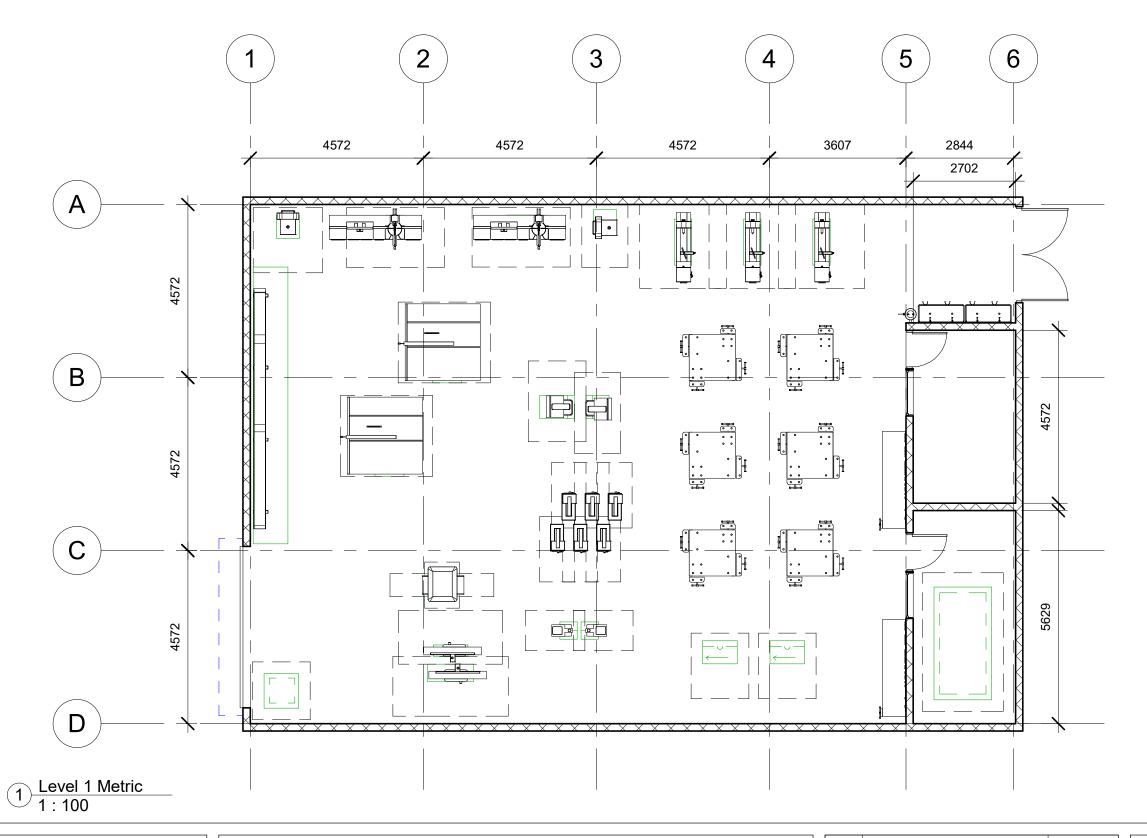

Room Schedule			
Name	Area	Metric	


Shop Floor	2655 SF	247 m²
Finishing	133 SF	12 m²
CNC	164 SF	15 m²

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No.	Description	Date

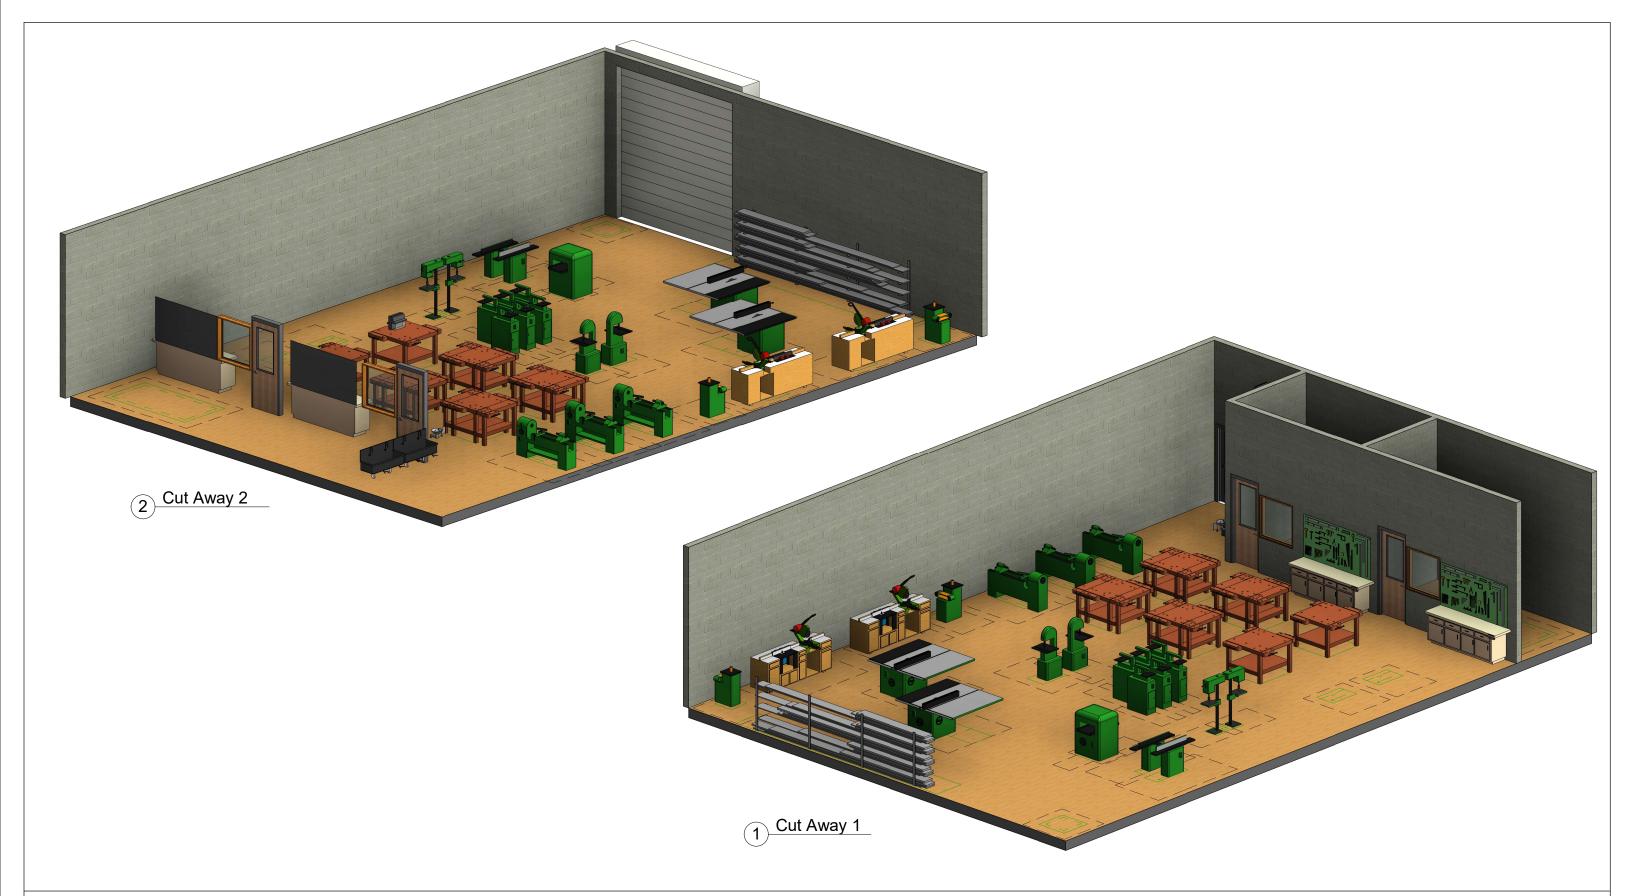Metric Details			
Project number V1			
Date	June 2017	A109	
Drawn by	Peter Halim		
Checked by	Checker	Scale 1 : 100	
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No.	Description	Date	
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3D Views			
Project number	V1		
Date	June 2017	A110	
Drawn by	Peter Halim		
Checked by	Checker	Scale	
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